



Vicinity Map – PLN2020-00133 - Joswiak Residence, Affordable Housing Unit, and Barn and Horse Barn


County of San Mateo – Planner: Camille Leung, Senior Planner April 16, 2021

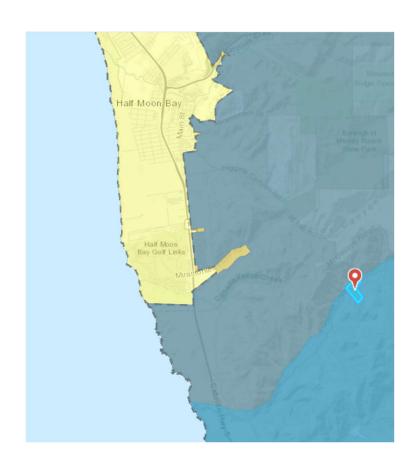

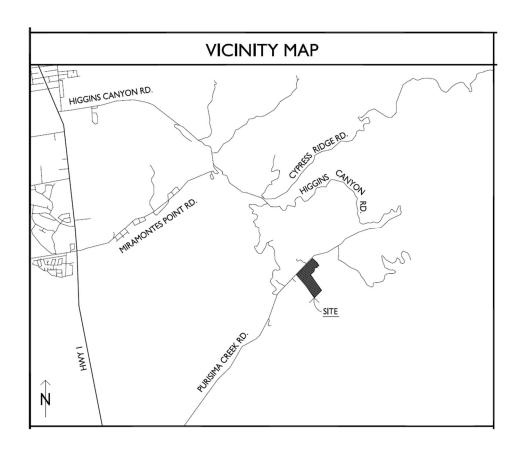

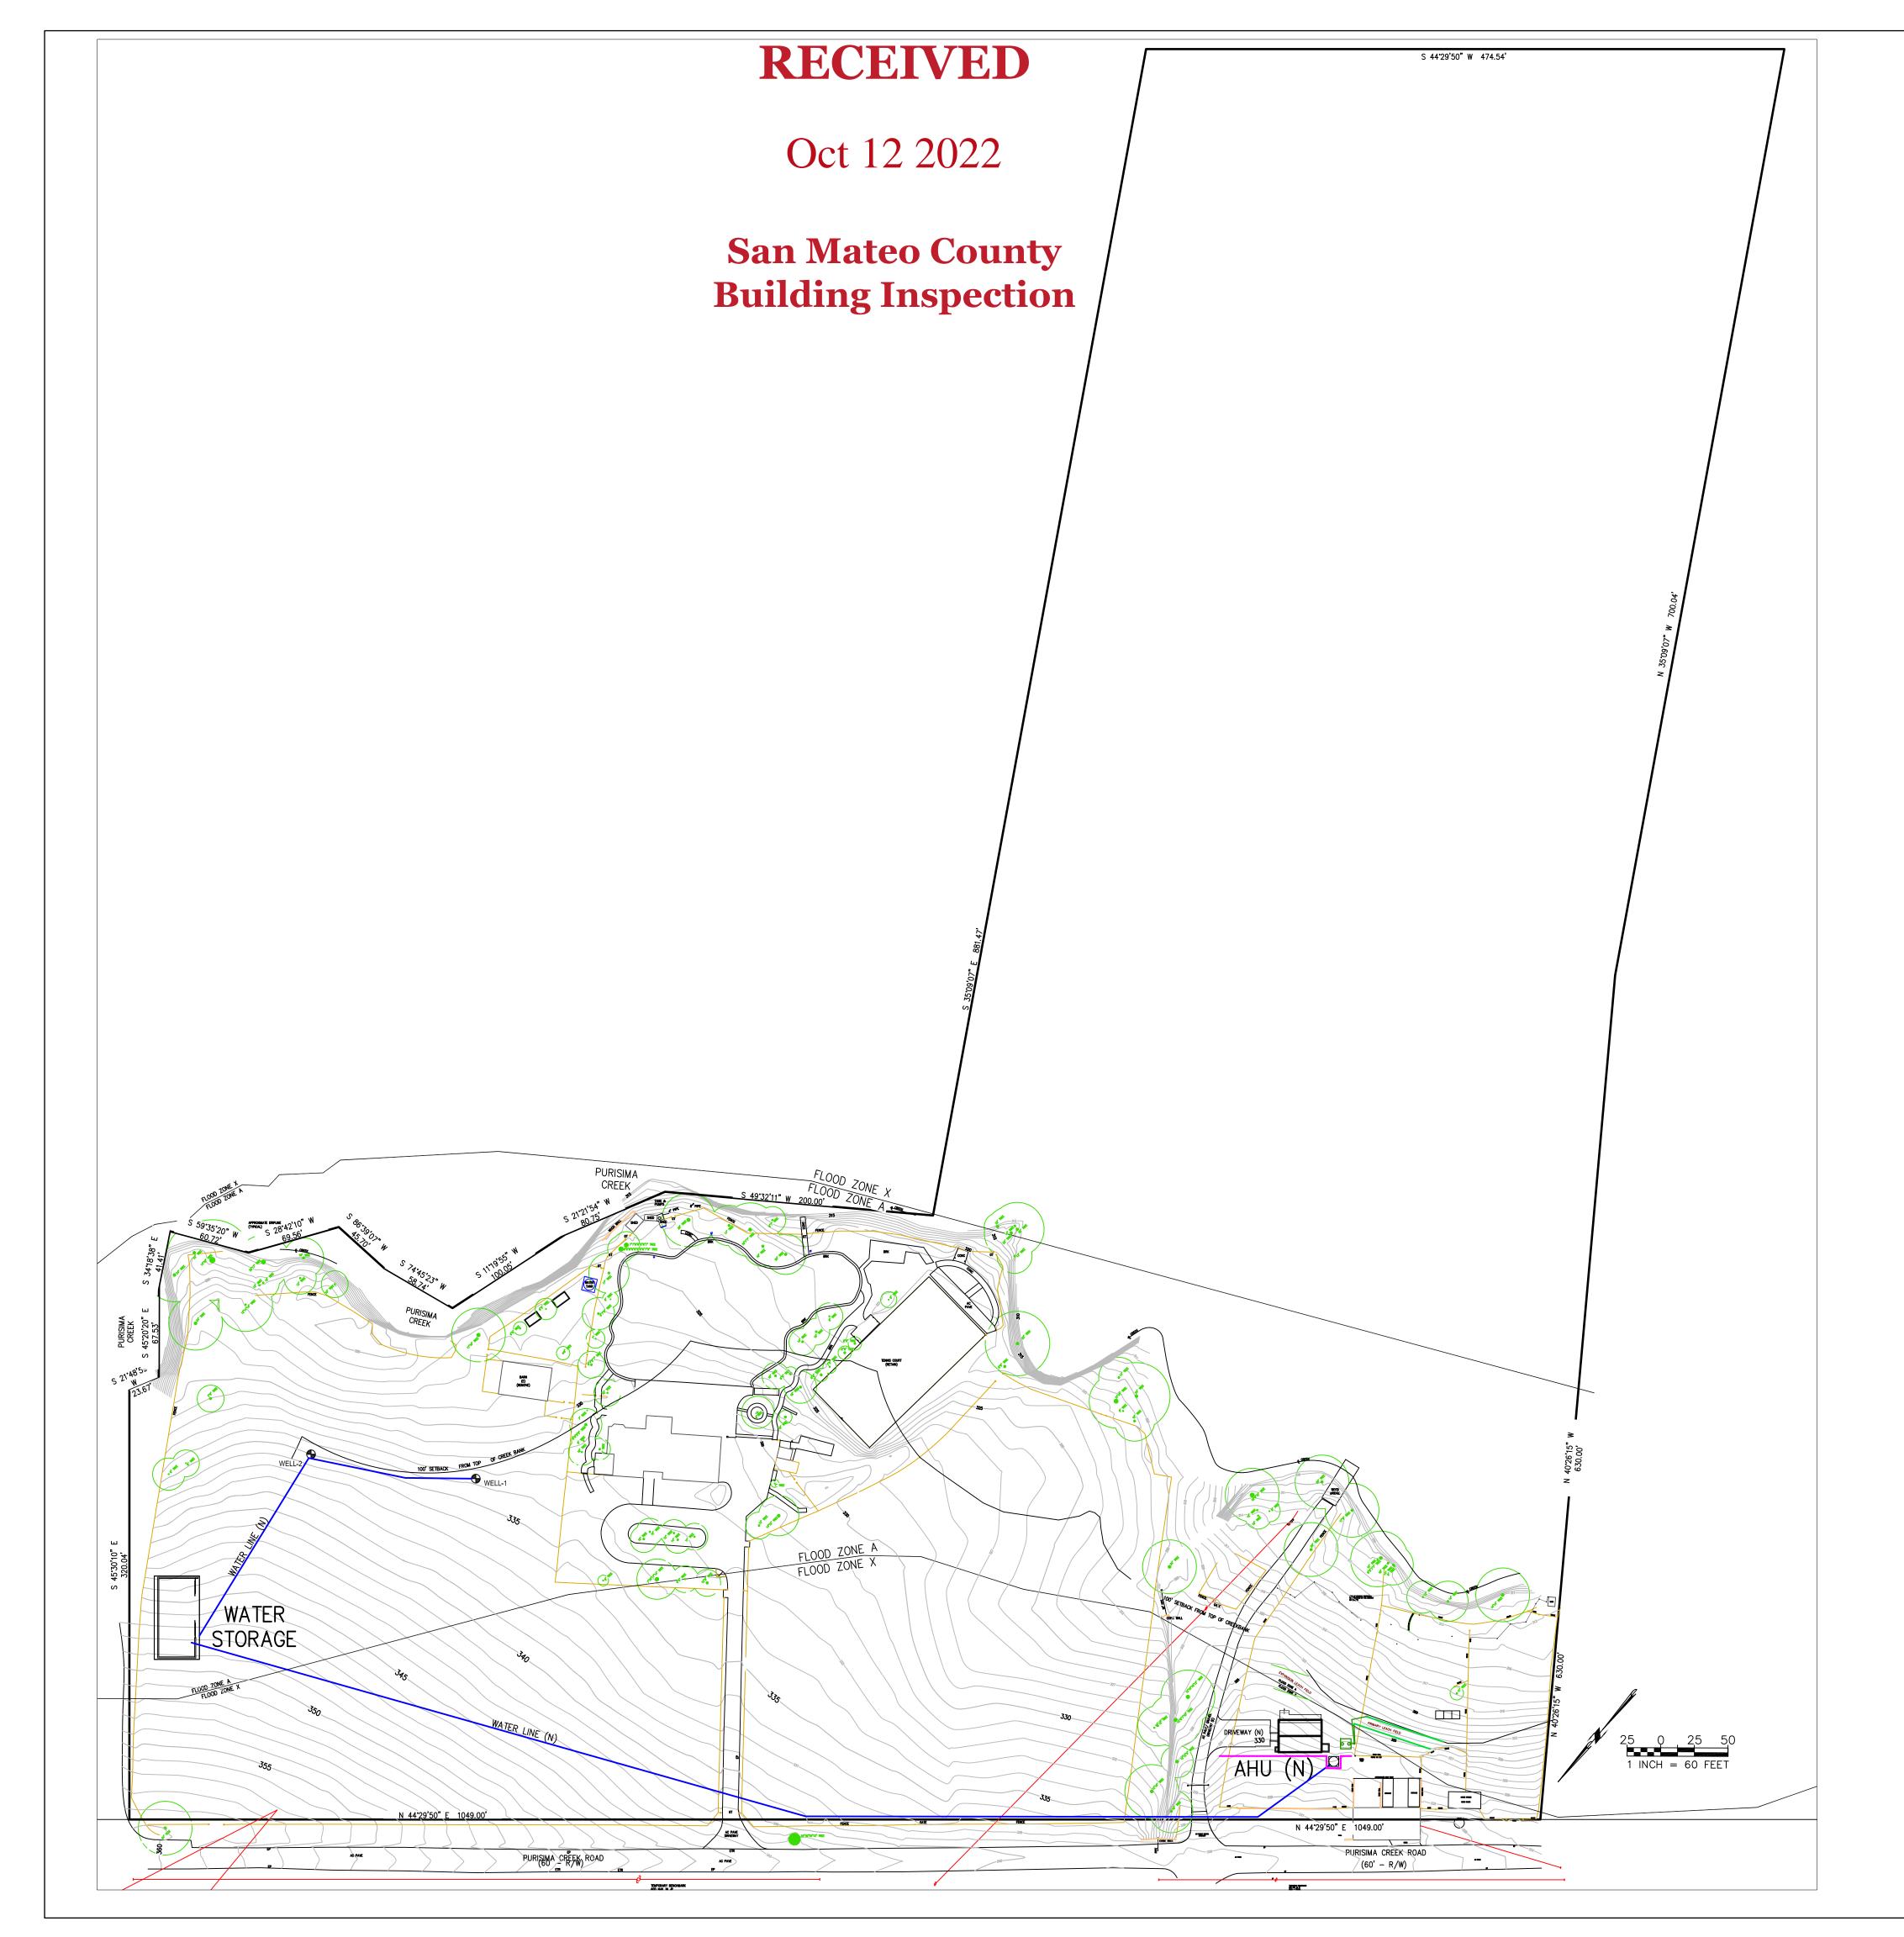

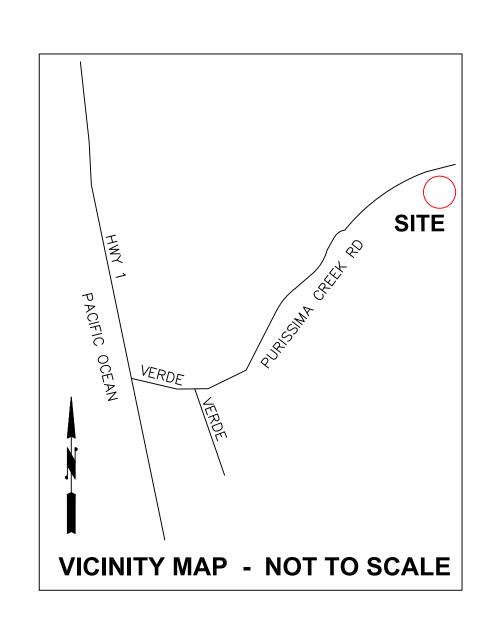

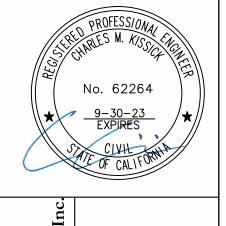

GENERAL NOTES

- PLANS PREPARED AT THE REQUEST OF: GREG JOSWIAK, OWNER
- 2. TOPOGRAPHY BY MACLEOD AND ASSOC., SURVEYED AUGUST, 2019.
- 3. THIS IS NOT A BOUNDARY SURVEY. 4. ELEVATION DATUM NAVD88.
- 5. THE GEOTECHNICAL REPORT: PENDING.

6. STORMWATER MANAGEMENT CONSTRUCTION INSPECTIONS SHALL BE SCHEDULED FOR APPLICABLE DRAINAGE INSPECTIONS, WHICH INCLUDE SITE CLEARANCE AND EROSION CONTROL MEASURES INSTALLATION AS WELL AS INSPECTION OF MAJOR DRAINAGE CONTAINMENT, TREATMENT, AND CONVEYANCE DEVICES BEFORE BEING BURIED (INCLUDING REQUIRED MATERIAL LABELS, E.G. PIPES, SUB-GRADE MATERIALS, ETC.). PLEASE FOLLOW THE INSPECTION CARD INSTRUCTIONS AND CALL SIGMA PRIME (650-728 3590) TO SCHEDULE DRAINAGE INSPECTIONS ACCORDINGLY. THERE SHALL BE THREE INSPECTIONS: ONE FOR EROSION CONTROL INSTALLATION, ONE BEFORE DRAINAGE FACILITIES ARE BURIED, AND ONE FOR FINAL WALK AROUND.

FEMA FLOOD ZONE NOTES

- 1. A LETTER OF MAP AMMENDMENT HAS BEEN APPROVED BY FEMA. 2. THE APPROVED BASE FLOOD ELEVATION ADJACENT TO THE MAIN HOUSE SITE IS 320.1 FEET.
- 3. THE PROPOSED FF ELEVATION OF THE MAIN FLOOR IS 334.75 FEET.

CIVIL PLAN SHEET INDEX

- C-1: SITE PLAN C-2: DRAINAGE PLAN
- C-3: GRADING PLAN
- C-4: EROSION AND SEDIMENT CONTROL PLAN
- C-5: WATER TO AHU

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SHEET

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Oct 12 2022 OCT 12

San Mateo County

Building Inspection
BUILDING INFORMATION:

GENERAL CODE COMPLIANCE

THESE PLANS ARE IN COMPLIANCE WITH THE FOLLOWING CALIFORNIA STATE REGULATIONS. ANY ERRORS OR OMISSIONS DO NOT WAIVE CODE REQUIREMENTS.

- 2019 CH.11A PART 2 CA BUILDING CODE
- 2019 CH.11B PART 2 CA BUILDING COD
- 2019 PART 2.5 CA RESIDENTAIL CODE
- 2019 PART 3 CA ELECTRICAL CODE
- 2019 PART 4 CA MECHANICAL CODE
- 2019 PART 5 CA PLUMBING CODE
- 2019 PART 6 CA ENERGY CODE
- 2019 PART 10 CA EXISTING BUILDING CODE
- 2019 PART 11 CA GREEN BUILDING

STANDARDS-CODE (CALGREEN) ALONG WITH ALL OTHER APPLICABLE

STATE AND LOCAL LAWS ORDINANCES AND REGULATIONS.

VENTILATION COMPLIANCE

WHOLE HOUSE VENTILATION USING A HEAT RECOVERY VENTILATION SYSTEM.

- LOCATION OF CONTROLS. CONTROLS FOR ALL VENTILATION SYSTEMS SHALL BE READILY ACCESSIBLE BY THE OCCUPANT.
- INSTRUCTIONS. OPERATING INSTRUCTIONS FOR WHOLE-HOUSE VENTILATION SYSTEMS SHALL BE PROVIDED TO THE OCCUPANT BY THE INSTALLER OF THE SYSTEM.
- ALL DUCT WORK IN HEAT RECOVERY SYSTEMS SHALL BE SIZED AND INSTALLED PER THE MANUFACTURER'S INSTRUCTIONS.
- HEAT RECOVERY VENTILATION SYSTEMS SHALL HAVE A FILTER ON THE UPSTREAM SIDE OF THE HEAT EXCHANGER IN BOTH THE INTAKE AND EXHAUST AIRSTREAMS WITH A MINIMUM EFFICIENCY RATING VALUE (MERV) OF 6.
- ALL SUPPLY DUCTS IN THE CONDITIONED SPACE INSTALLED UPSTREAM OF THE HEAT EXCHANGER SHALL BE INSULATED TO A MINIMUM OF R-4.
- INLETS SHALL BE SCREENED OR OTHERWISE PROTECTED FROM ENTRY BY LEAVES OR OTHER MATERIAL. OUTDOOR AIR INLETS SHALL BE LOCATED SO AS NOT TO TAKE AIR FROM THE FOLLOWING AREAS:
- •• CLOSER THAN 10 FEET FROM AN APPLIANCE VENT OUTLET, UNLESS SUCH VENT OUTLET IS 3 FEET ABOVE THE OUTDOOR AIR INLET.
- WHERE IT WILL PICK UP OBJECTIONABLE ODORS, FUMES OR FLAMMABLE VAPORS.
- A HAZARDOUS OR UNSANITARY LOCATION.
- A ROOM OR SPACE HAVING ANY FUEL-BURNING APPLIANCES THEREIN. CLOSER THAN 10 FEET FROM A VENT OPENING OF A
- PLUMBING DRAINAGE SYSTEM UNLESS THE VENT OPENING IS AT LEAST 3 FEET ABOVE THE AIR INLET. ATTIC, CRAWL SPACES, OR GARAGES.
- FLOW RATE REQUIREMENT 60 CFM. VENTILATION SYSTEM SET TO CONTINUOUS OPERATION.

MODULE SIZE: 8'-0" X 22'-0" (X4)

TOTAL UNIT SIZE: 32'-0" X 22'-0"

- OCCUPANCY TYPE: SINGLE FAMILY RESIDENTIAL OCCUPANCY LOAD:8(198 SF X/-PER OCCUPANT) **BUILDING LIMITATIONS: N/A**
- FOOTPRINT SIZE: 704SF TRUE INTERIOR LIVING SPACE: 663 SQ. FT
- LOCATION: STATE OF CALIFORNIA
- 1. BUILDING SHALL NOT BE LOCATED IN A FLOOD HAZARD
- 2. INSPECTION LABELS AND DATA PLATES TO BE LOCATED AT THE ELECTRICAL PANEL
- 3. THIS UNIT SHALL NOT BE LOCATED IN AN AREA THAT
- EXCEEDS ITS DESIGN LOADS 4. THIS BUILDING SHALL NOT BE USED AS AN ADDITION TO

CLOSER TO 10' FROM ANY OTHER UNIT

ANOTHER BUILDING 5. THIS BUILDING SHALL BE POSITIONED ON THE SITE NO


UNIT LABELS:

STATE OF CALIFORNIA HCD COMPLIANCE DECALS

SEALED DRAWINGS:

PROVIDED AND SEALED BY APPLICABLE STATE/PROVINCE REGISTERED ENGINEER FOR STRUCTURAL STEEL COMPONENTS ONLY

> Approved: State of CA Certified Design Approval Agency - NTA, Inc. 920268 proved: Factory Built Housing Plan Approval # HONO070722-12 Approval Date: 9/13/2022 Expiration Date: <u>9/13/2025</u>

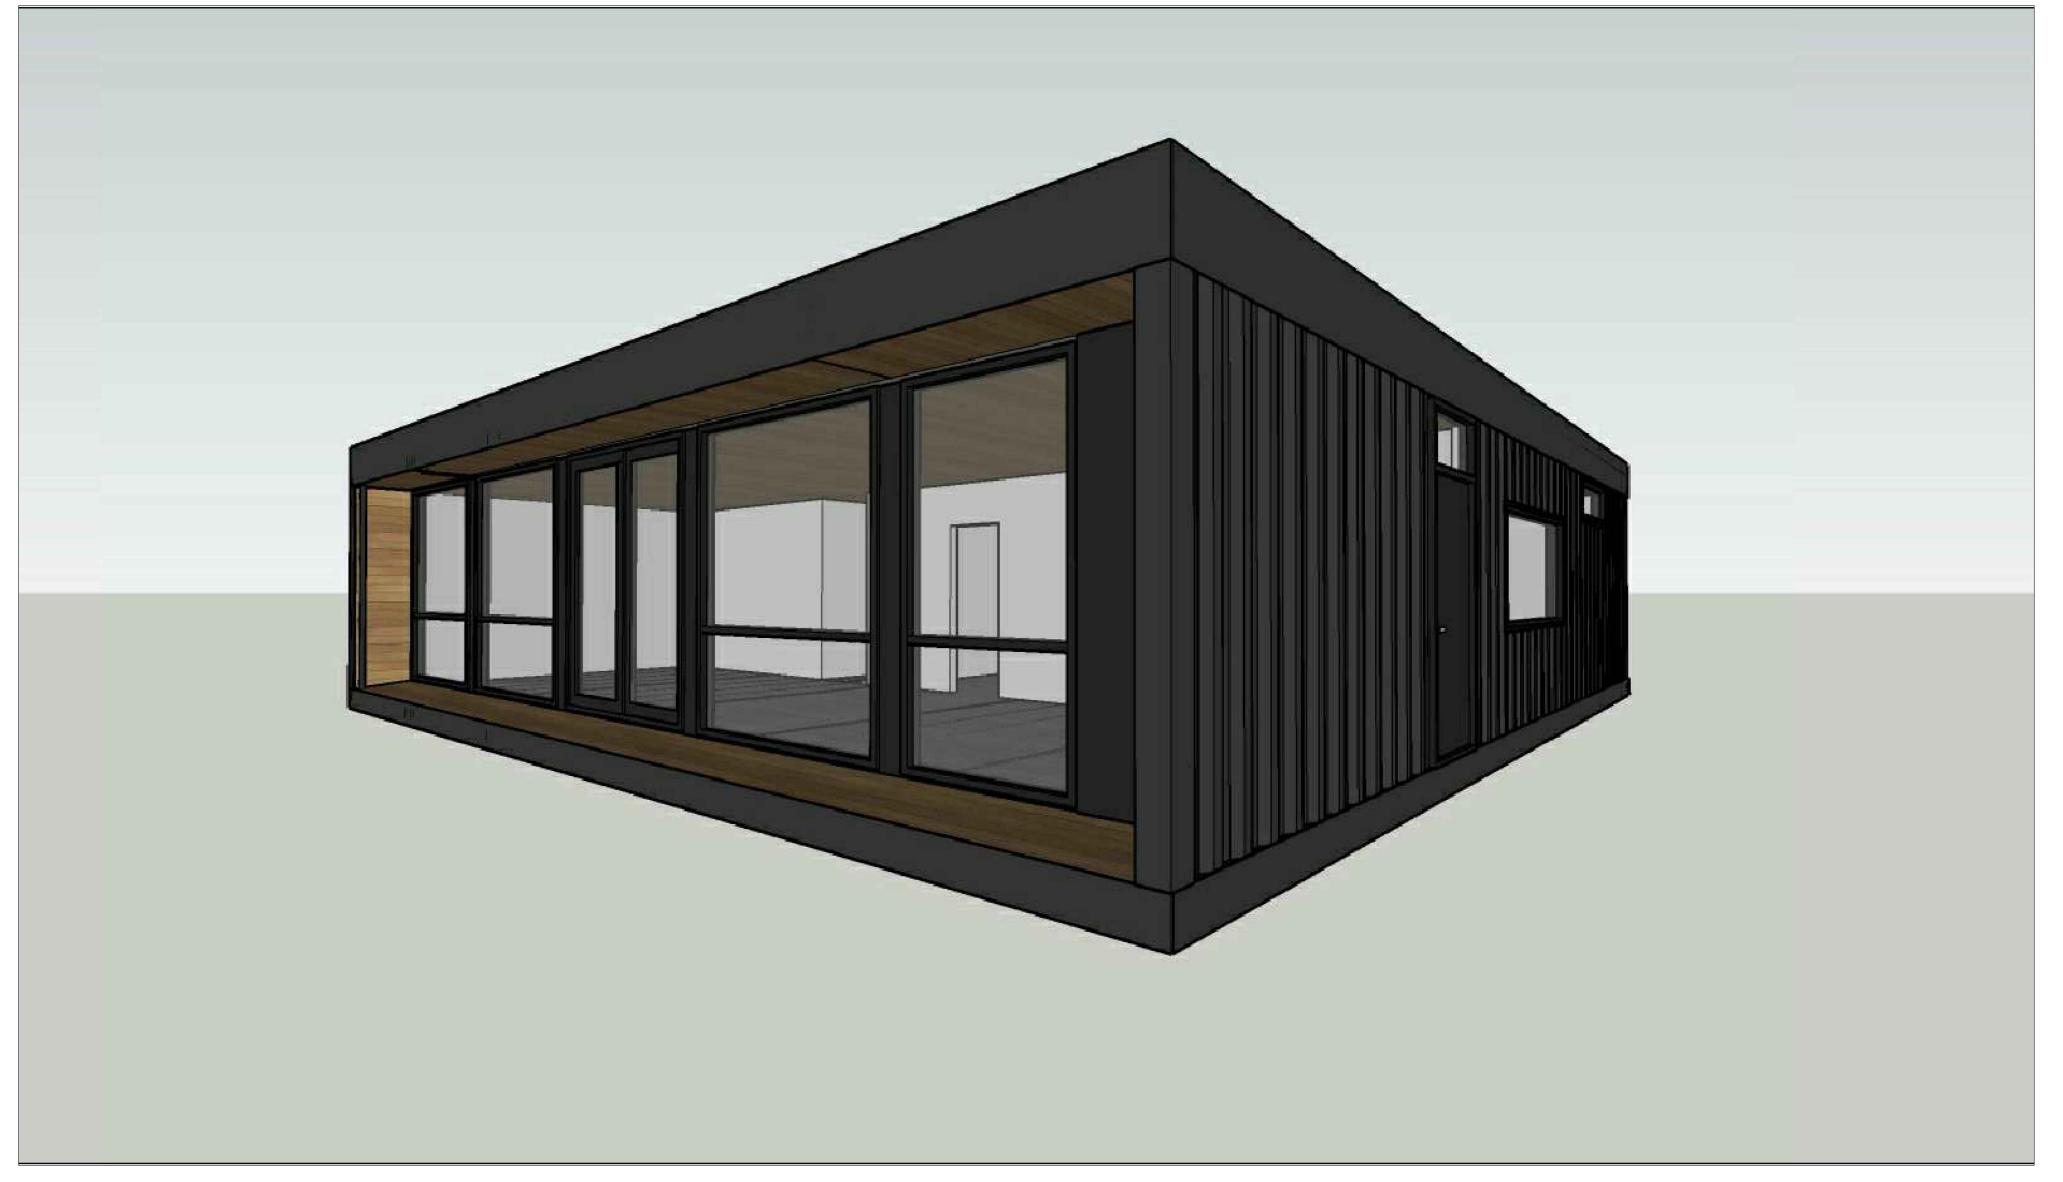

* IMAGE FOR ILLUSTRATION PURPOSES ONLY. FINAL PRODUCT MAY NOT BE EXACTLY AS SHOWN

ITEMS TO BE COMPLETED ON SITE

THE FOLLOWING ARE THE WORK THAT IS TO BE PERFORMED AT THE SITE AND NOT INCLUDED IN FACTORY BUILT PORTION OF THE

- **BUILDING:**
- PLACE HOUSE FOUNDATION HOME CONNECTION TO FOUNDATION HOOK UP UTILITIES:
- POWER-BY OTHERS
- WATER-BY OTHERS • SEWER/SEPTIC-BY OTHERS
- STORM WATER BY OTHERS
- EXTERIOR
- MODULE TO MODULE STRUCTURAL CONNECTIONS
- •• AT MODULE CONNECTIONS
- ••• ROOFING INTERCONNECT ••• BOLT PARAPET
- ••• SPRAY FOAM CAVITY VOID
- ••• PLACE PLYWOOD SHEATHING STRIP ••• WELD ROOFING MEMBRANE
- •• INSTALL SOFFITS AND DOWN SPOUTS •• INSTALL REAR FLASHING, BLUE SKIN AND FOAM - VERTICAL
- •• INSTALL REAR ROOF FLASHING
- •• INSTALL FRONT FLASHING/BLUE SKIN BETWEEN
- WINDOWS

- •• LANDINGS, DECKS AND/OR GUARDS BY OTHERS PRAY FOAM INSULATE UNDER SIDE OF HOME
- INTERIOR
- AT MODULE CONNECTIONS ••• FLOORING INTERCONNECT
- ••• INSTALL APPROX. 200 SQFT OVER INTERCONNECT
- •• STAND UP FRIDGE SET INTO PLACE
- PLACE KITCHEN ISLAND
- CONNECT DUCTWORK BETWEEN MODULES ELECTRICIAN TO CONNECT WIRING BETWEEN MODULES AND TO
- HOME-BY OTHERS
- •• BLOWER DOOR TESTING AND CERTIFICATION • CEILING SPRINKLERS INSTALLED BY OTHER
- •• INTERIOR CEDAR CEILING
- ELECTRICAL:
- TEMP POWER SERVICE
- PERMANENT SERVICE LINE AND METER PANEL
- UFER GROUND CONNECTION
- MODULE TO MODULE ELECTRICAL CONNECTIONS
- HEAT PUMP CONNECTION
- FIRE SUPPRESSION
- •• FIRE EXTINGUISHERS TO BE SUPPLIED AND INSTALLED ON SITE BY OTHERS IN ACCORDANCE WITH 2012 IBC
- •• FIRE SUPPRESSION SYSTEMS TO BE SITE INSTALLED BYLICENSED CONTRACTOR IN ACCORDANCE WITH THE 2012 IBC AND 2012 IFC

DRAWING LIST

- A1.1 FLOOR PLAN
- A1.2 REFLECTED CEILING PLAN
- A1.3 COLOUR SCHEDULE
- A1.4 EQUIPMENT PLAN
- A1.5 FRAMING PLAN A1.6 - DETAILS
- A1.7 INTERIOR ELEVATIONS
- A1.8 EXTERIOR ELEVATIONS
- P1.1 PLUMBING PLAN E1.1 - HIGH VOLTAGE ELECTRICAL PLAN
- E1.3 LOW VOLTAGE ELECTRICAL PLAN M1.1 - MECHANICAL PLAN

ABBREVIATIONS

- TYP. TYPICAL U/S - UNDERSIDE
- T/O TOP OF A.F.F. - ABOVE FLOOR FINISH N.I.C. - NOT IN CONTRACT

T.B.D. - TO BE DETERMINE

N/A - NOT APPLICABLE

CONTAINER NOTE

ALL SHIPPING CONTAINERS USED FOR THIS BUILDING ARE TO BE NEW, SHIPPED DIRECTLY FROM THE MANUFACTURER



MANUFACTURED BY:

HONOMOBO- 2102 5th ST.


NISKU, AB

T9E 7X3

HCD APPROVED

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FLOOR PLAN


| SCALE: 1/2" = 1'-0"

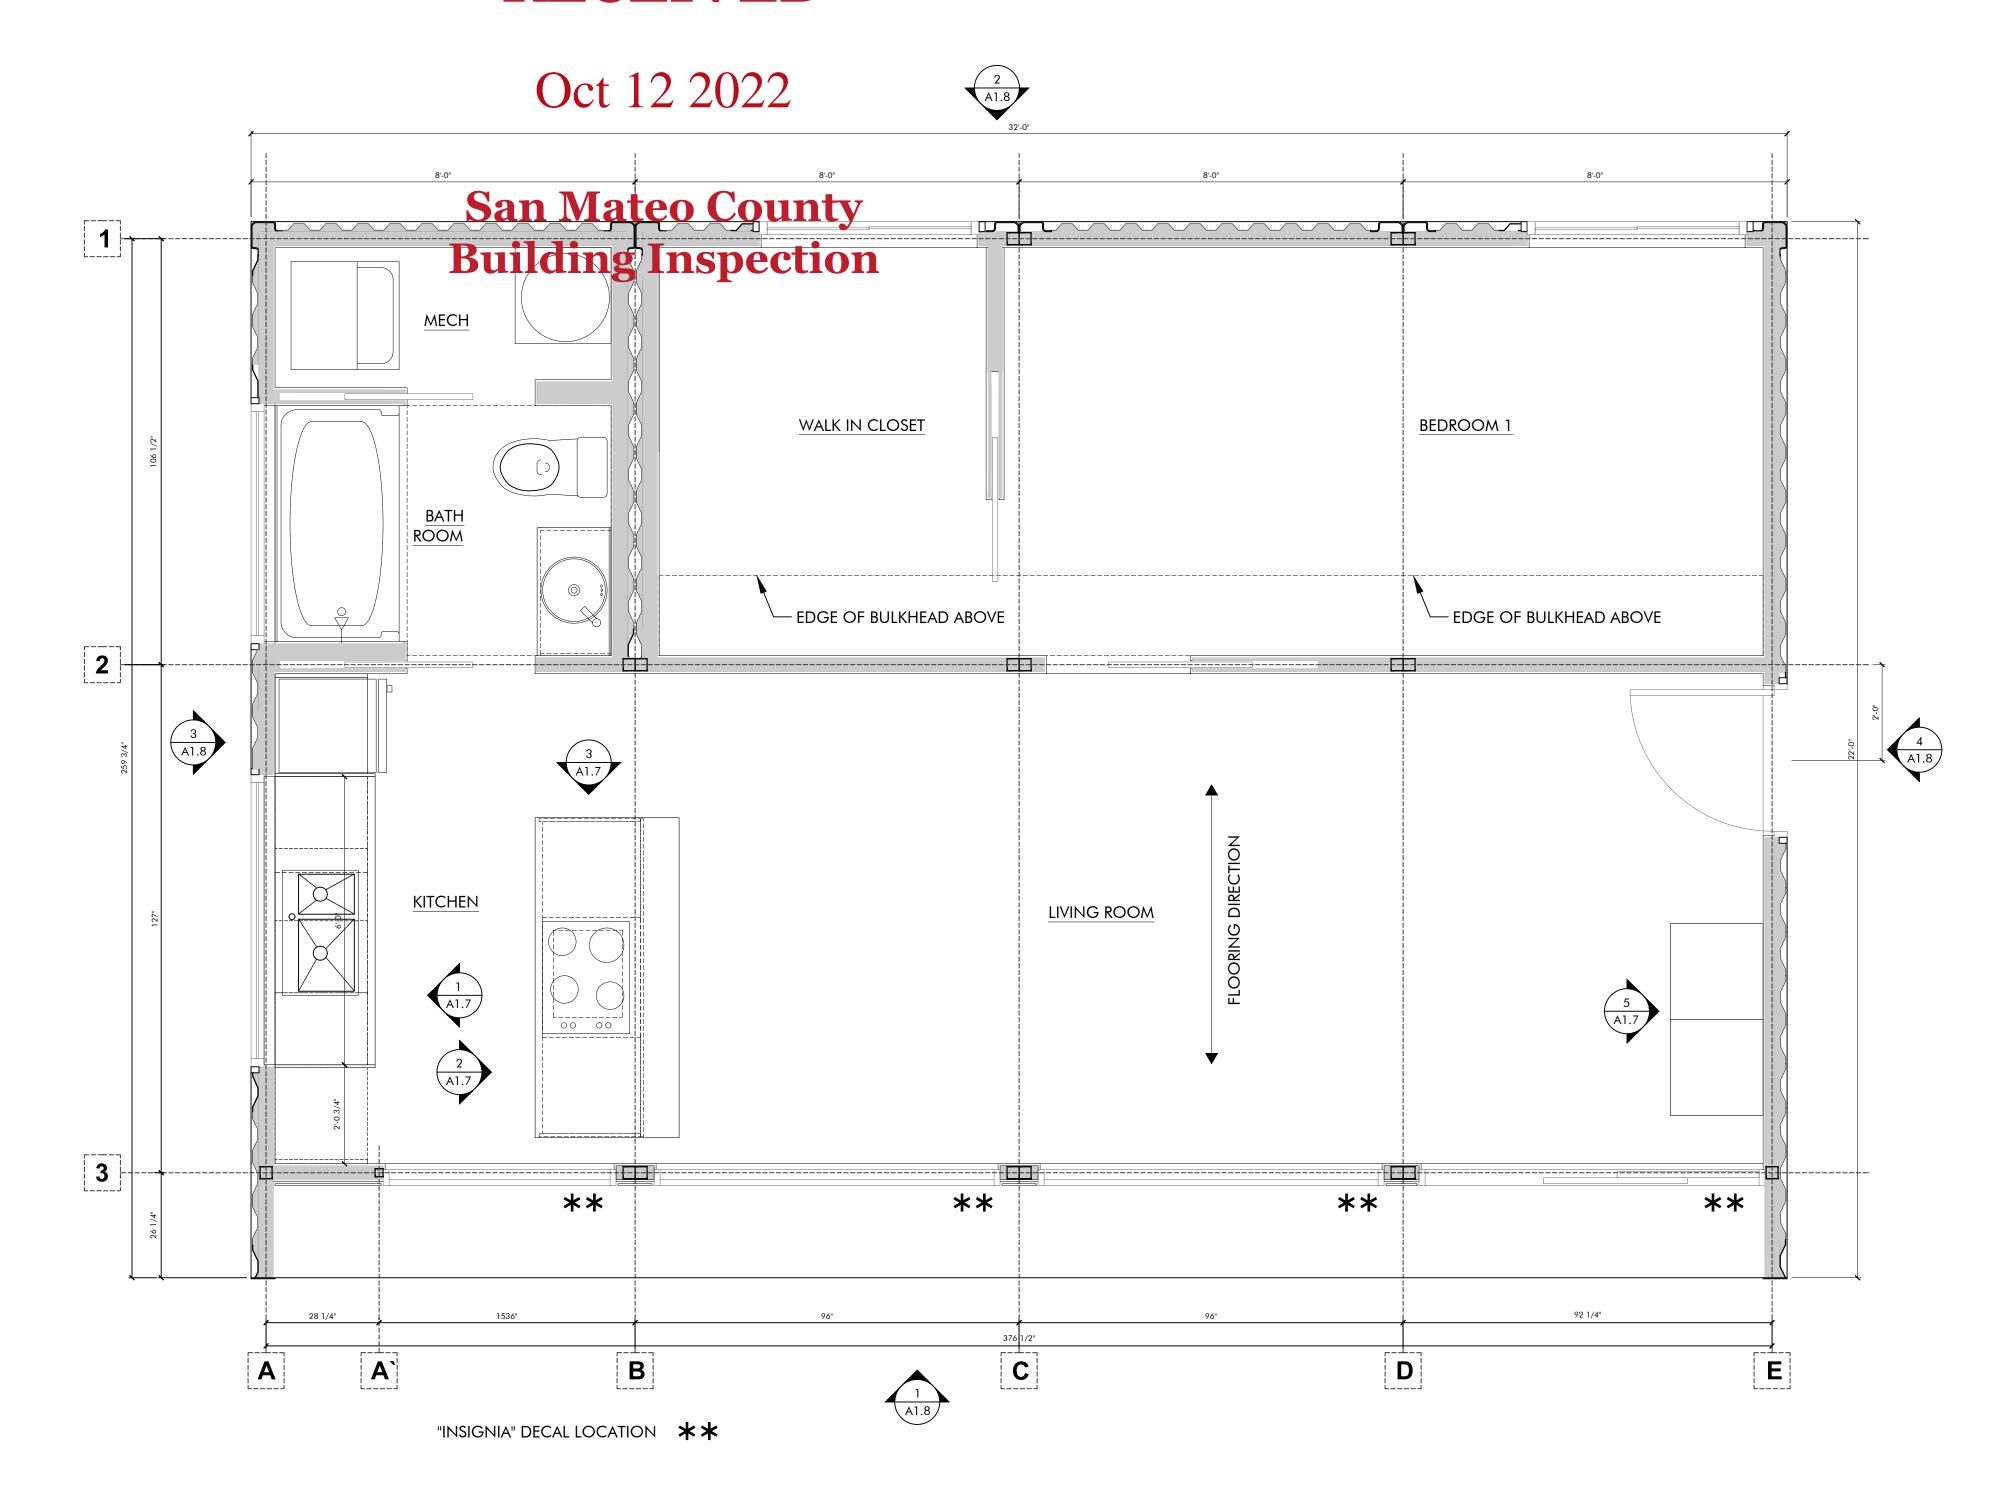Approved: State of CA
Certified Design Approval Agency - NTA, Inc. 920268
Approved: Factory Built Housing

NTA Plan Approval # HONO070722-12

Approval Date: 9/13/2022

Expiration Date: 9/13/2025

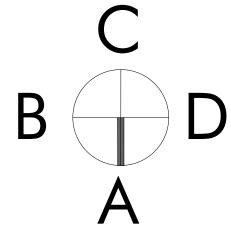



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DEPARTMENT:

SEAL/STAMP:

REVISIONS/ISSUE DATA

REV#	DESCRIPTION	DATE	E
0	ISSUED FOR PERMITS	04.08. 22	

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PROJECT:

HONOMOBO
HO530 FALVEY
250 PURISIMA CREEK RD
LOCATION:

HALF MOON BAY, CA. 94019

SHEET TITLE:		FLOO	R PLAN
CAD FILE:		HO530) FLAVEY
DRAWN BY:	RC	DATE:	04.08.2022
CHECKED BY:		SHEET NO:	A1.1